

NOTE

· Proposals must comply with all acoustic, fire & building regulation requirements

No dimensions are to be scaled from this drawing. The contractor is responsible for checking all dimensions on site

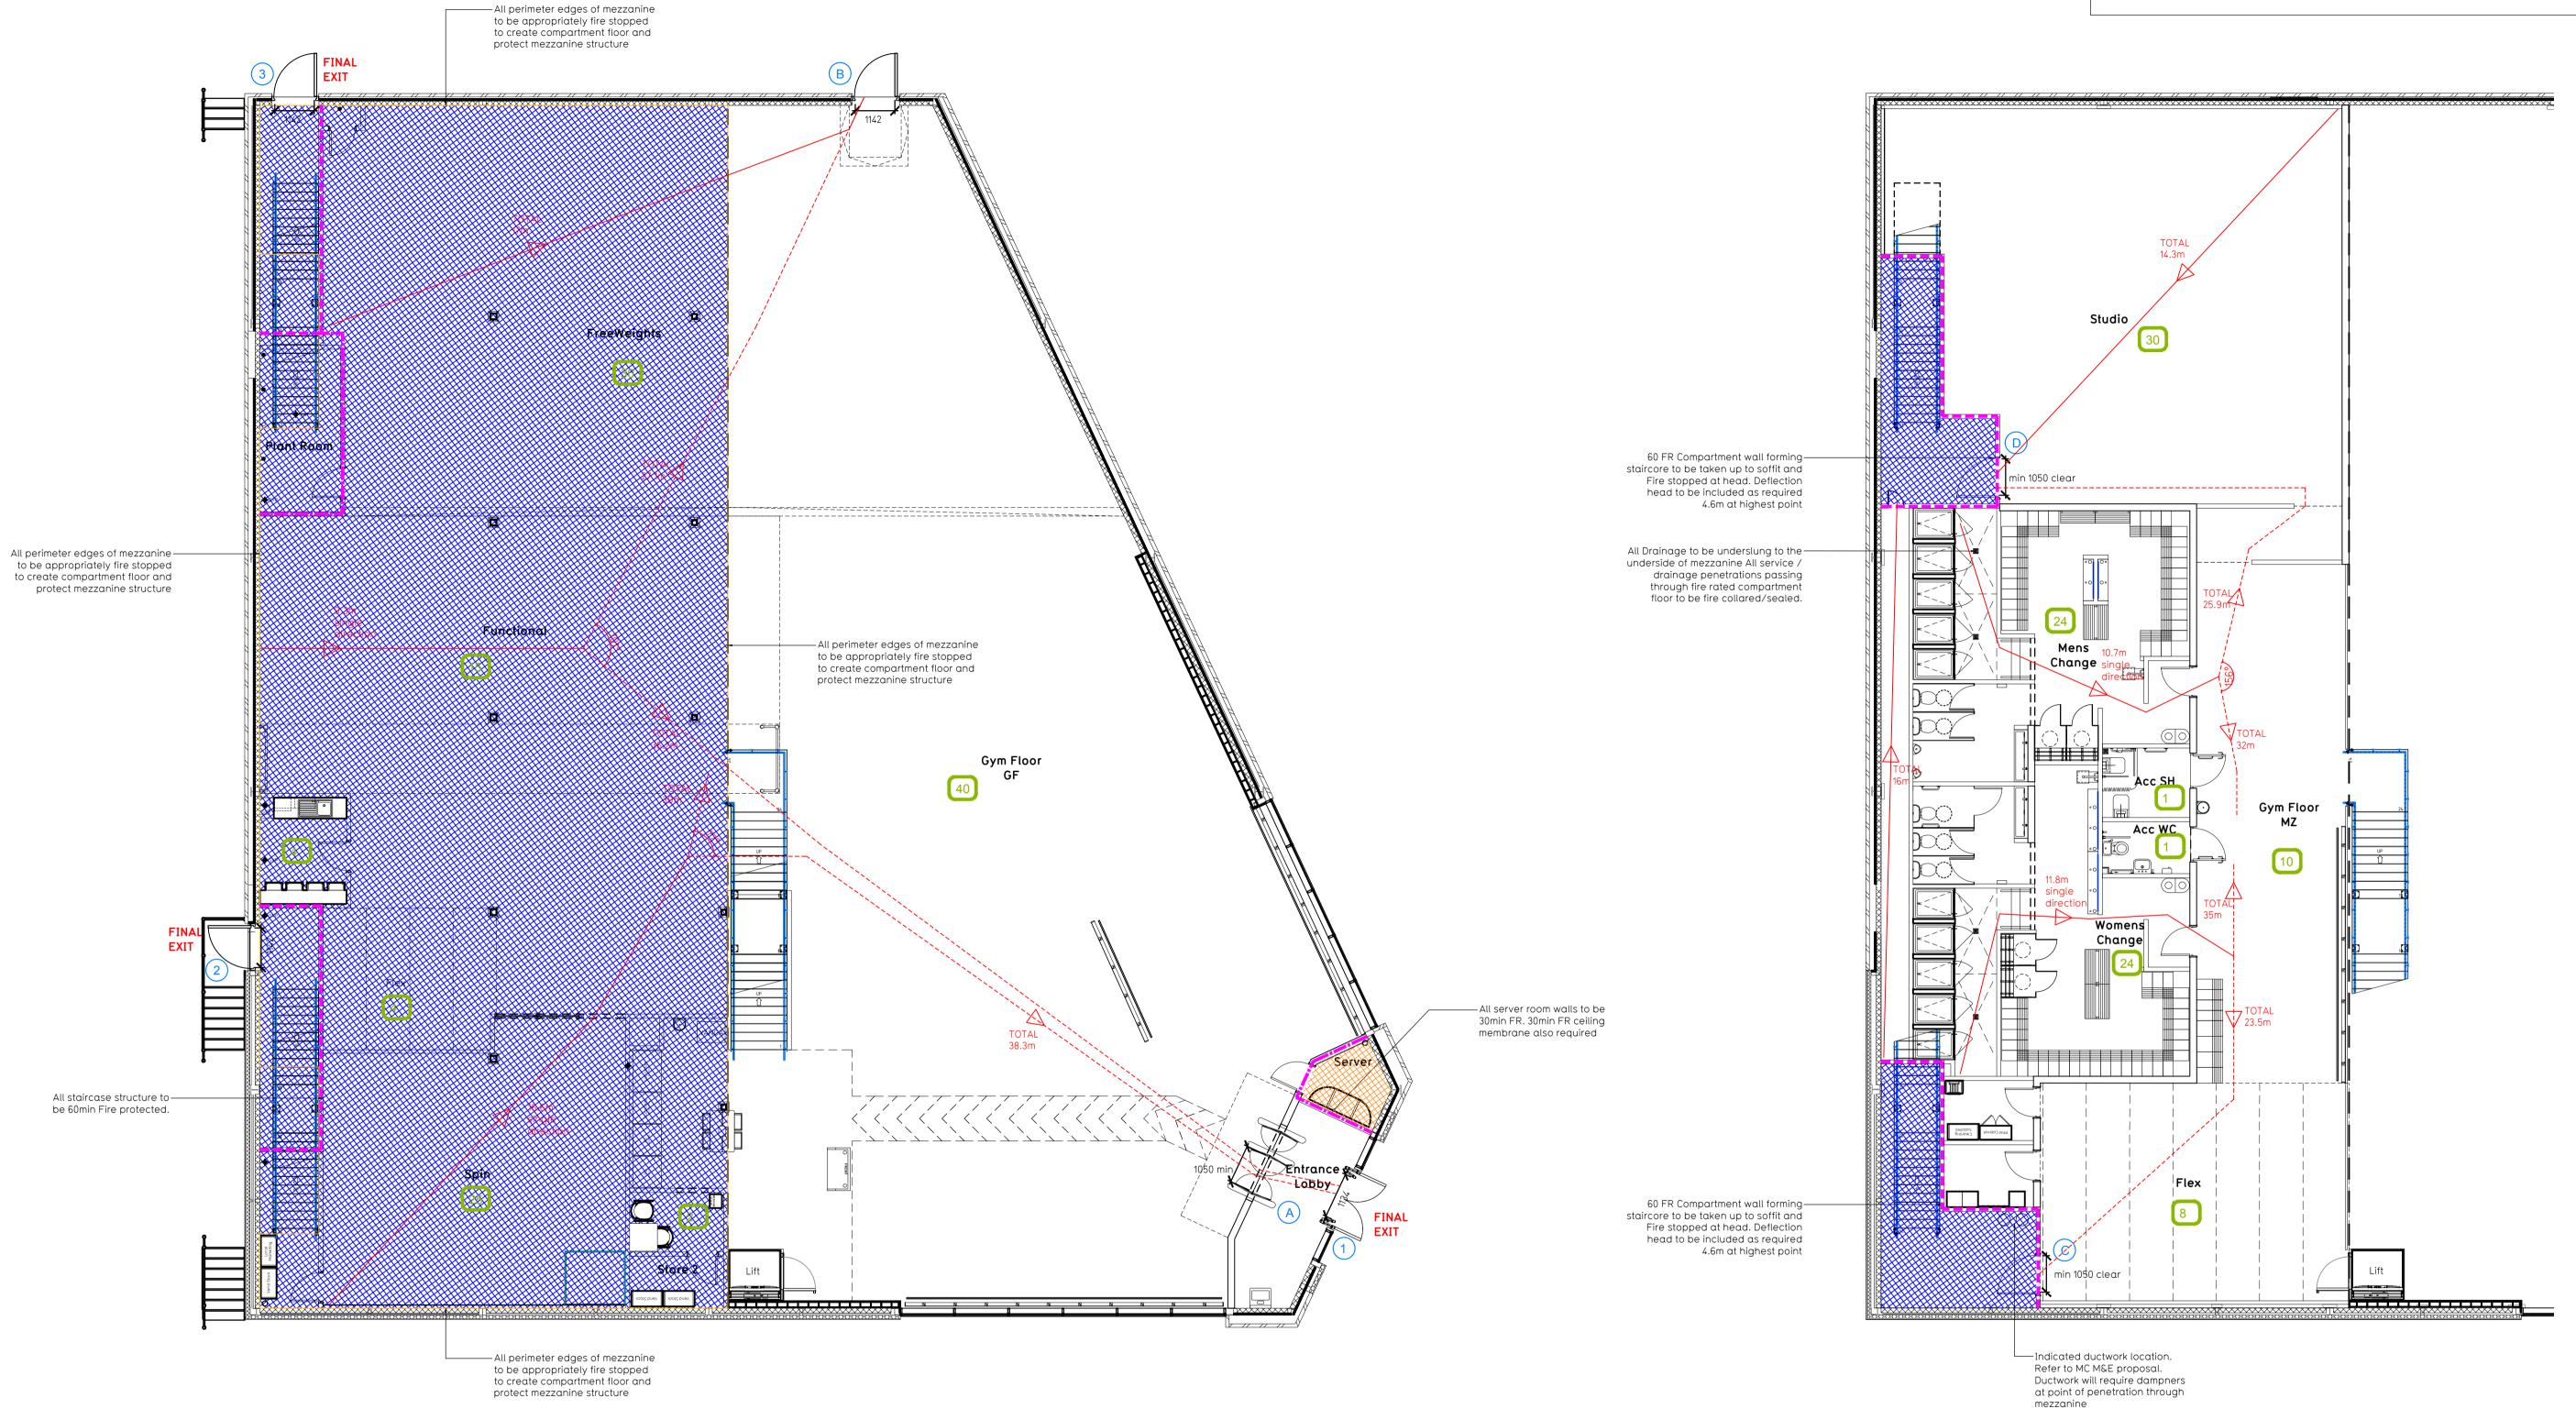

Proposed Ground Floor Plan

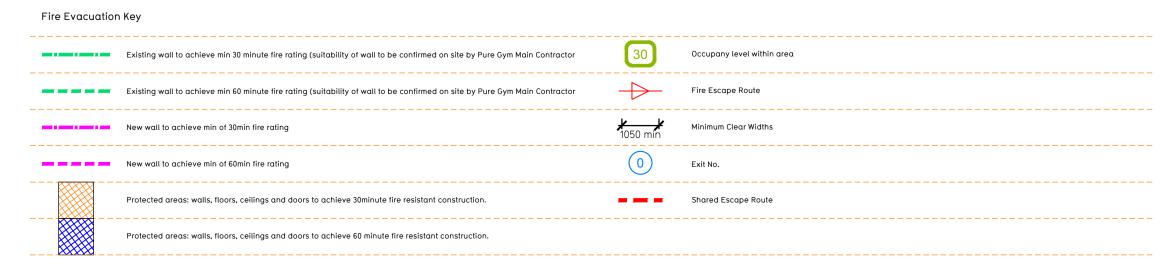

Escape Route Widths:
In line with Sections 3.21 & 3.22 of 'Approved Document Part B, Volume 2 - buildings other than dwellinghouses' - the adjacent calculations provide justification for the clear opening widths for escape from each floor level/room in accordance with Table 4 & Appendix C.

Ground Floor

Storey Exit A Clear Opening Width = 1050mm (allows 220 persons to escape)

Final Exit B Clear Opening Width = 1142mm (allows 238 persons to escape, largest opening to be discounted)

Total Aggregate Width for Floor (Less Largest Opening Width of 1142mm from EXIT B) = 1050mm

Ground Floor Total Estimated Occupancy Capacity = 120 Persons

EXIT A provides a min. width of 1050mm and would allow a max. No. of 220 persons to escape, which is larger than the total estimated occupancy capacity of 120 Persons and is therefore thought to meet with the Approved Document Part B.

Mezzapine Floor

Mezzanine Floor

Storey Exit C Clear Opening Width = 1050mm (allows 220 persons to escape)

Storey Exit D Clear Opening Width = 1050mm (allows 220 persons to escape, largest opening to be discounted)

Total Aggregate Width for Floor (Less Largest Openiz p ng Width of 1050mm from EXIT D) = 1050mm

Mezzanine Floor Total Estimated Occupancy Capacity = 98 Persons

capacity of 98 Persons and is therefore thought to meet with the Approved Document Part B.

Exit 1 Clear Opening Width = 1134mm (escape occupancy limited by Storey Exit A = 220 persons)
Exit 2 Clear Opening Width = 1142mm (escape occupancy limited by Storey Exit C = 220 persons)
Exit 3 Clear Opening Width = 1142mm (escape occupancy limited by Storey Exit D = 220 persons)

Exit 1 caters for ground floor only (via exit A) and allows the ground floor occupancy to escape and is thought to meet with the Approved Document Part B.

Exit 2 caters for mezzanine floor only (via exit C) and allows the mezzanine floor occupancy to escape and is thought to meet with the Approv Document Part B.

Exit 3 caters for mezzanine floor only (via exit D) and allows the mezzanine floor occupancy to escape and is thought to meet with the Approv Document Part B.

Fire Alarm
Fire Alarm designed and installed to BS 5839. Smoke & heat detection / emergency lighting by specialist. Please refer to M&E engineer's drawings / specifications.

Escape Lighting
Emergency escape lighted designed and installed in accordance with BS 5266: Part 1. Please refer to M&E Engineer's drawings for final layout and specification.
Escape Signage and emergency lighting is CDP under the M&E specification. Details of contractors proposals to be provided to Building Control Approved Inspector and Fire Officer within the Contractors Proposals Package, Clause 1.4

C01 14.02.2	Layout updated to ref from Mezzanine flex a proposals				IR/PG
Rev Date	Description		AWING TITLE		Drawn/ Checked
Notting	ham West Bridgf	ord	Fire Evacuation P	lan	
Unit 4, Wilfo	rd Lane Retail Park, Nottingha	am, NG2 7QY	Ground/Mezzanin		
Unit 4, Wilfo RAWN / CHECK HI/IR	rd Lane Retail Park, Nottingha  DATE  09.02.22	am, NG2 7QY (SCALE 1:100 @ A1	Ground/Mezzanin JOB No 1036	ne Floor Plans DRAWING N 003 - FE	Р
Unit 4, Wilfo RAWN / CHECK HI/IR DRAWING PURPO	rd Lane Retail Park, Nottingha  DATE  09.02.22	am, NG2 7QY	JOB No	DRAWING N	_